

CITY OF SACRAMENTO

1231 I Street, Sacramento, CA 95814

Permit No: 0110390

Insp Area: 4

Thos Bros: 256 G7

Site Address: 3501 BROADGATE DR SAC

Parcel No: 225-1480-042

IN EXISTING VAULT

Sub-Type: NCOM

Housing (Y/N): N

CONTRACTOR

ROBERT F LEWIS
152 PHEASANT DR
GALT, CA 95632

OWNER

PACIFIC BELL

ARCHITECT

Nature of Work: NEW PHONE SWITCHING VAULT, 200 AMP SERVICE PANEL

CONSTRUCTION LENDING AGENCY : I hereby affirm under penalty of perjury that there is a construction lending agency for the performance of the work for which this permit is issued (Sec. 3097, Civ. C).

Lender's Name _____

Lender's Address _____

LICENSED CONTRACTORS DECLARATION: I hereby affirm under penalty of perjury that I am licensed under provisions of Chapter 9 (commencing with section 7000) of Division 3 of the Business and Professions Code and my license is in full force and effect.

X License Class C10 License Number 607692 X Date 9-5-01 X Contractor Signature Robert F. Lewis

OWNER-BUILDER DECLARATION: I hereby affirm under penalty of perjury that I am exempt from the contractors License Law for the following reason (Sec. 7031.5, Business and Professions Code; any city or county which requires a permit to construct, alter, improve, demolish, or repair any structure, prior to its issuance, also requires the applicant for such permit to file a signed statement that he or she is licensed pursuant to the provisions of the Contractors License Law (Chapter 9 (commencing with Section 7000) of Division 8 of the Business and Professions Code) or that he or she is exempt therefrom and the basis for the alleged exemption. Any violation of Section 7031.5 by any applicant for a permit subjects the applicant to a civil penalty of not more than five hundred dollars (\$500.00);

____ I, as a owner of the property, or my employees with wages as their sole compensation, will do the work, and the structure is not intended or offered for sale (Sec. 7044, Business and Professional Code: The Contractors License Law does not apply to an owner of property who builds or improves thereon, and who does such work himself or herself or through his/her own employees, provided that such improvements are not intended or offered for sale. If, however, the building or improvement is sold within one year of completion, the owner-builder will have the burden of proving that he/she did not build or improve for the purpose of sale.)

____ I, as owner of the property, am exclusively contracting with licensed contractors to construct the project (Sec. 7044, Business and Professions Code: The Contractors License Law does not apply to an owner of property who builds or improves thereon, and who contracts for such projects with a contractor(s) licensed pursuant to the Contractors License Law).

____ I am exempt under Sec. _____ B & PC for this reason: _____

Date _____ Owner Signature _____

IN ISSUING THIS BUILDING PERMIT, the applicant represents, and the city relies on the representation of the applicant, that the applicant verified all measurements and locations shown on the application or accompanying drawings and that the improvement to be constructed does not violate any law or private agreement relating to permissible or prohibited locations for such improvements. This building permit does not authorize any illegal location of any improvement or the violation of any private agreement relating to location of improvements.

I certify that I have read this application and state that all information is correct. I agree to comply with all city and county ordinances and state laws relating to building construction and hereby authorize representative(s) of this city to enter upon the abovementioned property for inspection purposes.

X Date 9-5-01 X Applicant/Agent Signature Robert F. Lewis

WORKER'S COMPENSATION DECLARATION: I hereby affirm under penalty of perjury one of the following declarations:

____ I have and will maintain a certificate of consent to self-insure for workers' compensation as provided for by Section 3700 of the Labor Code, for the performance of work for which the permit is issued.

____ I have and will maintain workers' compensation insurance, as required by Section 3700 of the Labor Code, for the performance of the work for which this permit is issued. My workers' compensation insurance carrier and policy number are:

Carrier NO EMPLOYEES

Policy Number

Exp Date

ALL (This section need not be completed if the permit is for \$100 or less) I certify that in the performance of the work for which this permit is issued, I shall not employ any person in any manner so as to become subject to the workers' compensation laws of California and agree that if I should become subject to the workers' compensation provisions of Section 3700 of the Labor Code, I shall forthwith comply with those provisions.

X Date 9-5-01 X Applicant Signature Robert F. Lewis

WARNING: FAILURE TO SECURE WORKER'S COMPENSATION COVERAGE IS UNLAWFUL AND SHALL SUBJECT AN EMPLOYER TO CRIMINAL PENALTIES AND CIVIL FINES UP TO ONE HUNDRED THOUSAND DOLLARS (\$100,000) IN ADDITION TO THE COST OF COMPENSATION, DAMAGES AS PROVIDED FOR IN SECTION 3706 OF THE LABOR CODE, INTEREST AND ATTORNEY'S FEE.

THIS PERMIT SHALL EXPIRE BY LIMITATION IF WORK IS NOT COMMENCED WITHIN 180 DAYS.

Plans on Microfilm



SMUD

SACRAMENTO MUNICIPAL UTILITY DISTRICT 6201 8 Street, P.O. Box 15830, Sacramento, CA 95852-1830. (916) 452-3211
AN ELECTRIC SYSTEM SERVING THE HEART OF CALIFORNIA

August 26, 2000

PACIFIC BELL
ATTENTION: PAUL CLARK

3675 T STREET, ROOM 170
P.O. BOX 15038
SACRAMENTO CA 95851

SUBJECT: ELECTRIC SERVICE REQUIREMENTS

Project Location: W/S BROADGATE DR, 500' N/O DEL PASO RD

WA # 74571

In order to schedule our job preparation and construction activity to provide timely permanent electric service to your development, the Sacramento Municipal Utility District (SMUD) requires the following:

- A. Property owner will sign and return the enclosed: 1. Conveyance of Electric Distribution Facilities; 2. Agreement to grant right-of-way (Note - this document must be signed in the presence of a Notary Public). SMUD construction cannot be scheduled until signed documents are returned.
- B. Developer's compliance with SMUD Rules and Electric Service Requirements. Copies are available upon request.
- C. Due to the time needed for scheduling, the deposit must be made a minimum of five weeks prior to the projects estimated start date or need for electrical facilities.
- D. A copy of the project grading or building permit to SMUD as soon as possible. Receipt of permit will initiate job preparation.
- E. Costs for relocating or modifying SMUD facilities, whether in a street or private right-of-way, as a result of a commercial, industrial, or apartment development, shall be reimbursed by the developer prior to any work being done by SMUD.
- F. The project coordinator should notify the SMUD estimator of any changes in the project's estimated start date to avoid unnecessary delays of SMUD construction.
- G. SMUD may need to secure right-of-way and/or permits from various public agencies and private parties to provide electric service to your development. SMUD construction cannot be scheduled until these requirements are satisfied. Please contact SMUD Estimator for details regarding this project.
- H. Party responsible for electric bills should make application for service with SMUD Customer Services Department at 1-888-742-7683 as soon as possible. Connection of electric service can be scheduled upon receipt of the electrical inspection by the city/county.
- I. Multi-unit building must be addressed in compliance with the enclosed addressing guidelines prior to connection of electric service. A copy of the site plan showing building addresses, unit numbers, and electric service locations should be received by SMUD Estimator at least ten (10) working days prior to obtaining City/County inspection approval in order to avoid service delays. Meters cannot be set until specific building addresses and unit numbers are known and clearly identified on building and electric service equipment.



SMUD

SACRAMENTO MUNICIPAL UTILITY DISTRICT

6201 S Street, P.O. Box 15830, Sacramento, CA 95852-1830. (916) 452-3211
AN ELECTRIC SYSTEM SERVING THE HEART OF CALIFORNIA

August 26, 2000

PACIFIC BELL
ATTENTION: PAUL CLARK

3675 T STREET, ROOM 170
P.O. BOX 15038
SACRAMENTO CA 95851

W.A. # 74571

SMUD COMMITMENT LETTER

Thank you for submitting your plans for W/S Broadgate Dr, 500' N/O Del Paso Rd for an electric service commitment. Your cooperation enables us to give you the best service possible, as well as provide for your future requirements.

We are returning one copy of your plans indicating the service location and other requirements checked below. Our commitment is subject to changing conditions and, as a result, may not be valid after twelve months.

Please contact the Estimator if additional information is desired.

Estimator: *Gaylin Fleming*
Gaylin Fleming

Telephone (916) 732-5801

Service will be: Overhead Underground

Volts: 120/208 Phase: Three Wire: 4 Type: Wye

(Street light service voltage will be the same as above.)

- Transformer pad required: Yes No SMUD Dwg. UVD 2.3 & 2.2
- Conduit required: Yes No (see sketch)
- Right-of-way required: Yes No
- Transformer protection required: Yes No see sketch and SMUD Dwg. N/A
- Primary pull box required: Yes No SMUD Dwg. UVG 1.2 & 1.2.2
- Service box required: Yes No SMUD Dwg. N/A
- Switchgear pad required: Yes No SMUD Dwg. N/A
- Street light service box required: Yes No (see sketch)

Other requirements: See enclosed Booklet Prints

*A maximum fault current of 10,400 amps symmetrical is based on the largest transformer that could be needed to serve the Single Combined main sizes of 200A amps.

Metering will be outside, if possible. If in a meter room, door must be keyed for SMUD key. Contact the Estimator for details.

*If future load growth necessitates increasing the main switch size, the available fault current should be recalculated.

NOTE: This commitment letter may be required by local inspection authority as part of its plan check requirements.

Electric Service Agreement Page - 2

J. The project coordinator will conduct a pre-construction meeting prior to the start of trenching for the electric system. No inspection will be performed until the meeting has been held. To schedule the meeting, please call your SMUD Senior Engineering Estimator two full working days prior to scheduled meeting.

Joe Alejandrez, 296-7753 Bruce Boswell, 761-6530 Larry Elliott, 761-6528
 Al Sanders, 761-6531 Buddy Timms, 505-9785


Please retain these requirements for your information.

Sincerely,



Gaylin Fleming
Senior Engineering Estimator
New Services Division
Distribution Services
(916) 732-6801

REV	DATE

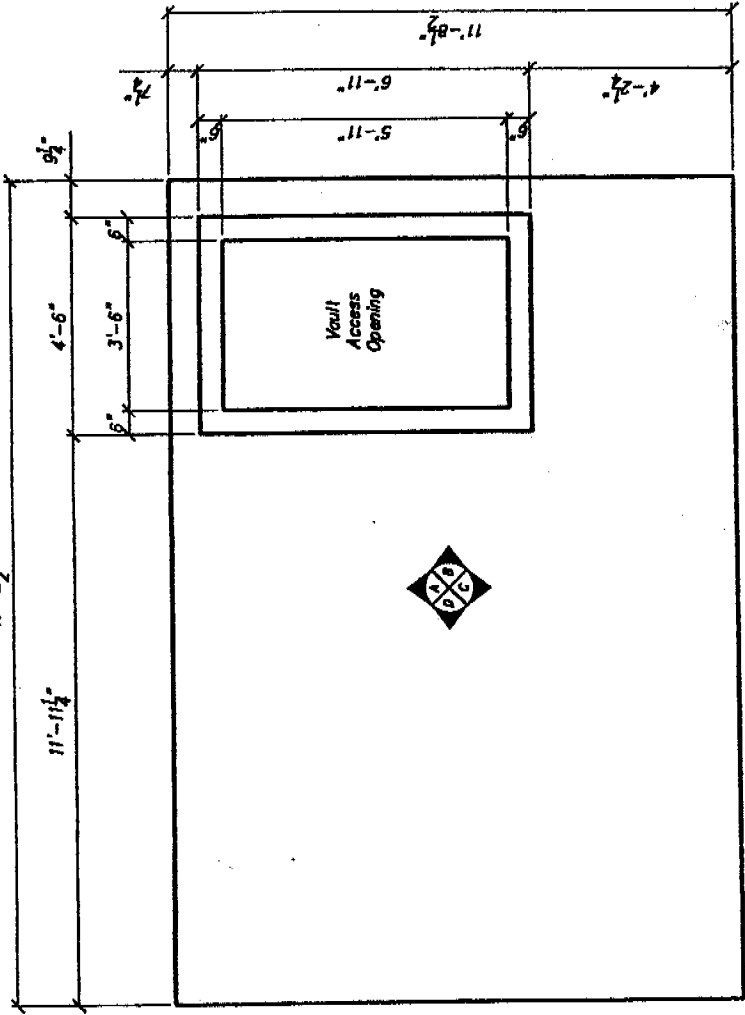

OVERHEAD VIEW

STRUCTURAL NOTES:

- 1.) CONCRETE: 28 DAY COMPRESSIVE STRENGTH F_C = 5000 PSI
- 2.) REBAR: ASTM A-615 GRADE 60
- 3.) MESH: ASTM A-185 GRADE 95
- 4.) DESIGN: ACI-318-99 BUILDING CODE
ASTM C-857 "MINIMUM STRUCTURAL DESIGN
LOADING FOR UNDERGROUND PRECAST CONCRETE
UTILITY STRUCTURES"
- 5.) LOADS: MS20-44 W/30K IMPACT PER AASHTO

GENERAL NOTES:

- 1.) ALL JOINTS SHALL BE SEALED USING CONSAL CS-101 BUTYL RUBBER ROPE.

- Denotes Exterior Elevation View Of Vault
- Denotes Interior Wall Elevation View In Vault

CEV WEIGHT

Top: 54,000 lbs. With Collar
Base: 49,000 lbs.

DATE	REV	DATE	REV
02/24/00			
THIS DRAWING IS THE PROPERTY OF THE UTILITY VAULT COMPANY. IT IS LOANED TO YOU FOR YOUR PROJECT ONLY AND IS NOT TO BE REPRODUCED OR USED IN ANY MANNER WITHOUT THE WRITTEN CONSENT OF THE UTILITY VAULT COMPANY.		SCALE 1/2" = 1'-0" 3/4" = 1'-0" 1" = 1'-0" 1 1/4" = 1'-0" 1 1/2" = 1'-0" 1 3/4" = 1'-0" 2" = 1'-0" 2 1/4" = 1'-0" 2 1/2" = 1'-0" 2 3/4" = 1'-0" 3" = 1'-0" 3 1/4" = 1'-0" 3 1/2" = 1'-0" 3 3/4" = 1'-0" 4" = 1'-0" 4 1/4" = 1'-0" 4 1/2" = 1'-0" 4 3/4" = 1'-0" 5" = 1'-0" 5 1/4" = 1'-0" 5 1/2" = 1'-0" 5 3/4" = 1'-0" 6" = 1'-0" 6 1/4" = 1'-0" 6 1/2" = 1'-0" 6 3/4" = 1'-0" 7" = 1'-0" 7 1/4" = 1'-0" 7 1/2" = 1'-0" 7 3/4" = 1'-0" 8" = 1'-0" 8 1/4" = 1'-0" 8 1/2" = 1'-0" 8 3/4" = 1'-0" 9" = 1'-0" 9 1/4" = 1'-0" 9 1/2" = 1'-0" 9 3/4" = 1'-0" 10" = 1'-0" 10 1/4" = 1'-0" 10 1/2" = 1'-0" 10 3/4" = 1'-0" 11" = 1'-0" 11 1/4" = 1'-0" 11 1/2" = 1'-0" 11 3/4" = 1'-0" 12" = 1'-0" 12 1/4" = 1'-0" 12 1/2" = 1'-0" 12 3/4" = 1'-0" 13" = 1'-0" 13 1/4" = 1'-0" 13 1/2" = 1'-0" 13 3/4" = 1'-0" 14" = 1'-0" 14 1/4" = 1'-0" 14 1/2" = 1'-0" 14 3/4" = 1'-0" 15" = 1'-0" 15 1/4" = 1'-0" 15 1/2" = 1'-0" 15 3/4" = 1'-0" 16" = 1'-0" 16 1/4" = 1'-0" 16 1/2" = 1'-0" 16 3/4" = 1'-0" 17" = 1'-0" 17 1/4" = 1'-0" 17 1/2" = 1'-0" 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Controlled Environment Vault (CEV)
Model 1018-106 Standard (Generations2000)
Pacific Bell

ORDER NO. 02/24/00
 DRAWING NO. J3000-1
 SHEET 1 OF 1
 REV. 1
 P.O. Box 218, Chandler, AZ 85244
 (480) 950-3875 Fax: (480) 950-1127

UTILITY VAULT
 REDUCED PRINT
 1/2 Original Scale

Oldcastle Precast, Inc.

PANEL SCHEDULE EXAMPLE

PANEL: <i>A</i>		VOLTAGE: <i>120/208</i>				BUS: <i>200 AMP</i>			
TYPE: <i>200 AMP C/B</i>		PHASE <i>1</i> WIRE <i>3</i>				MOUNT: <i>SURFACE</i>			
LOAD	KVA	C.B.	NO.	S/N	NO.	C.B.	KVA	LOAD	
		<i>20</i>	<i>1</i>		<i>2</i>	<i>15</i>	<i>1.6</i>	<i>Ceiling lights</i>	
<i>Outlets RFI</i>		<i>15</i>	<i>3</i>		<i>4</i>	<i>15</i>		<i>EMERG. Lights</i>	
<i>R.P. # 1</i>	<i>3.2</i>	<i>30</i>	<i>5</i>		<i>6</i>	<i>15</i>		<i>Microprocessor</i>	
		<i>30</i>	<i>7</i>		<i>8</i>	<i>15</i>			
<i>Rectifier # 1</i>	<i>2.9</i>	<i>30</i>	<i>9</i>		<i>10</i>	<i>30</i>	<i>3.2</i>	<i>ITC # 2</i>	
		<i>30</i>	<i>11</i>		<i>12</i>	<i>30</i>			
<i>Rectifier # 2</i>	<i>2.9</i>	<i>30</i>	<i>13</i>		<i>14</i>	<i>30</i>	<i>2.9</i>	<i>Rectifier # 3</i>	
		<i>30</i>	<i>15</i>		<i>16</i>	<i>30</i>			
<i>SUBG SUP.</i>	<i>0</i>	<i>20</i>	<i>17</i>		<i>18</i>	<i>30</i>	<i>2.9</i>	<i>Rectifier # 4</i>	
		<i>20</i>	<i>19</i>		<i>20</i>	<i>30</i>			
			<i>21</i>		<i>22</i>				
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			<i>37</i>		<i>38</i>				
			<i>39</i>		<i>40</i>				
			<i>41</i>		<i>42</i>				

100% CONNECTED LOAD
 CONTINUOUS LOAD
 LARGEST MOTOR LOAD *3.2*
 TOTAL LOAD:

TOTAL KVA = *19.6*
 KVA @ 25% = _____
 KVA @ 25% = *800*
40.00 KVA
 KVA / .360 = *111.4*


ISSUED

SEP 05 2007

Sacramento Building Division

This set of plans and specifications must be kept on the job at all times and it is unlawful to make any changes or alterations from the same without written permission from the Building Inspection Division.

The approval of this plan and specification SHALL NOT be held to permit or approve the

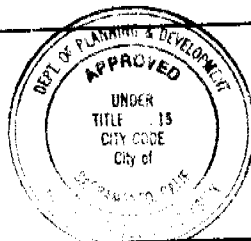


BID Form #

Revision Date: 04/05/99


Drawn By: RSB

AutoCAD File.

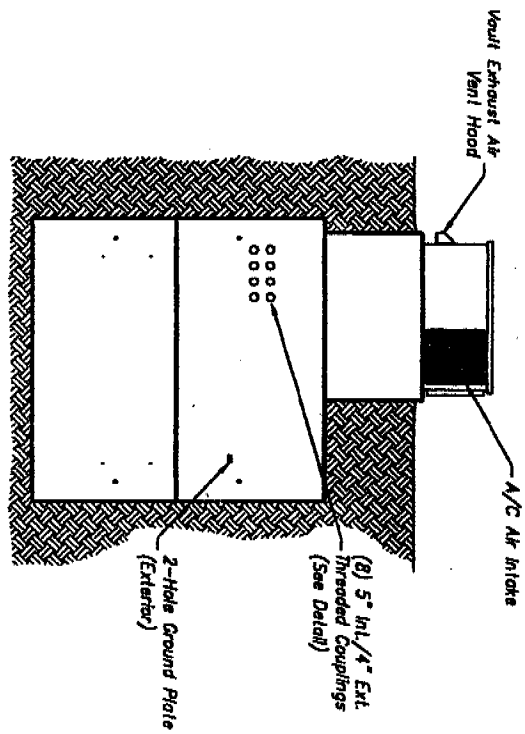


Note: Attach 3 Feet Of #2 Bare Solid Copper Wire (Cramped And Soldered) To 2-Hole Ground Lug (Typ. ● Both Exterior Locations)


EXTERIOR ELEVATION VIEW "A"

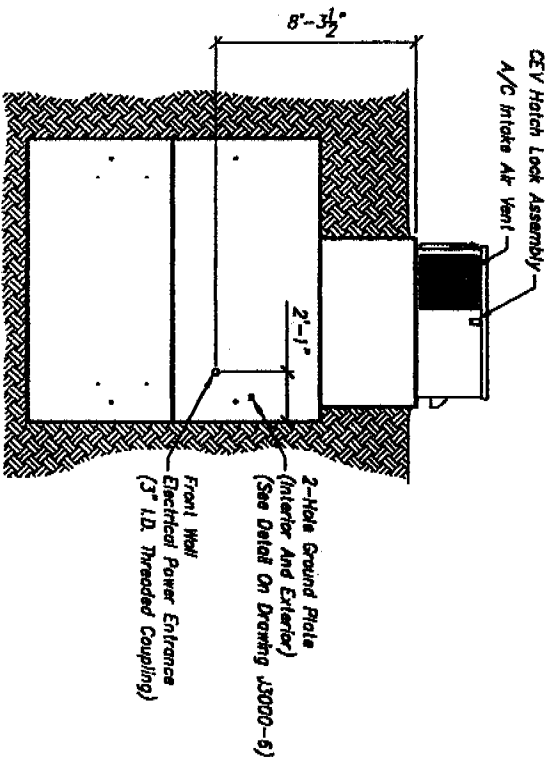


EXTERIOR ELEVATION VIEW "C"

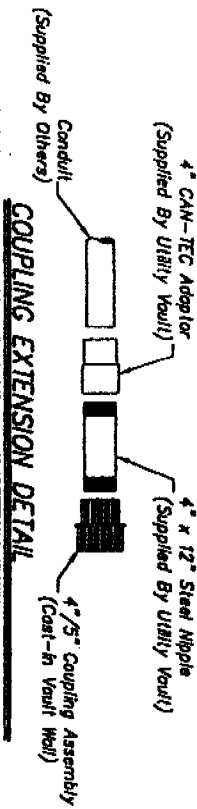

COUPLING EXTENSION DETAIL

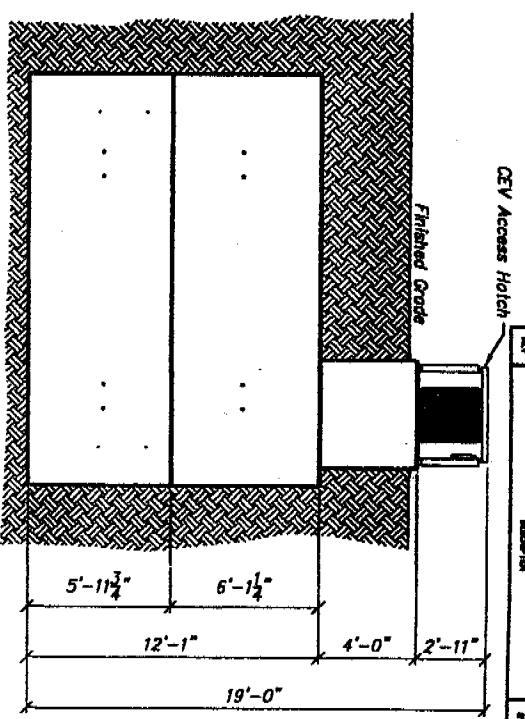

EXTERIOR ELEVATION VIEW "B"

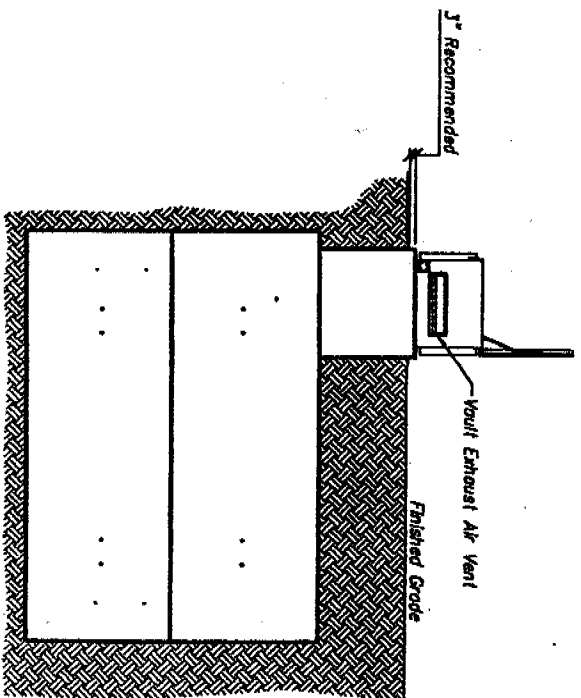

EXTERIOR ELEVATION VIEW "D"


Note: Power Pedestal And Transfer Switch Provided By Pacific Bell

REDUCED PRINT
1/2 Original Scale

DATE: 02/21/00	REV: 1	BY: J3000-2
DESIGNED: [Blank]	CHECKED: [Blank]	APPROVED: [Blank]
Model 1016-106 Standard (Generation2000) Pacific Bell		
CONTROLLED ENVIRONMENT VAULT (CEV) Model 1016-106 Standard (Generation2000)		ORDER NO: J3000-2
1900 DRAWING IS THE PROPERTY OF THE COMPANY AND IS NOT TO BE REPRODUCED, COPIED, OR TRANSMITTED IN ANY FORM OR BY ANY MEANS, ELECTRONIC OR MECHANICAL, WITHOUT THE WRITTEN PERMISSION OF THE COMPANY.		ORDER NO: J3000-2

UTILITY VAULT™
 P.O. Box 870 Chandler, AZ 85244
 (480) 968-0276 Fax: (480) 968-1987

Oldcastle Precast, Inc.

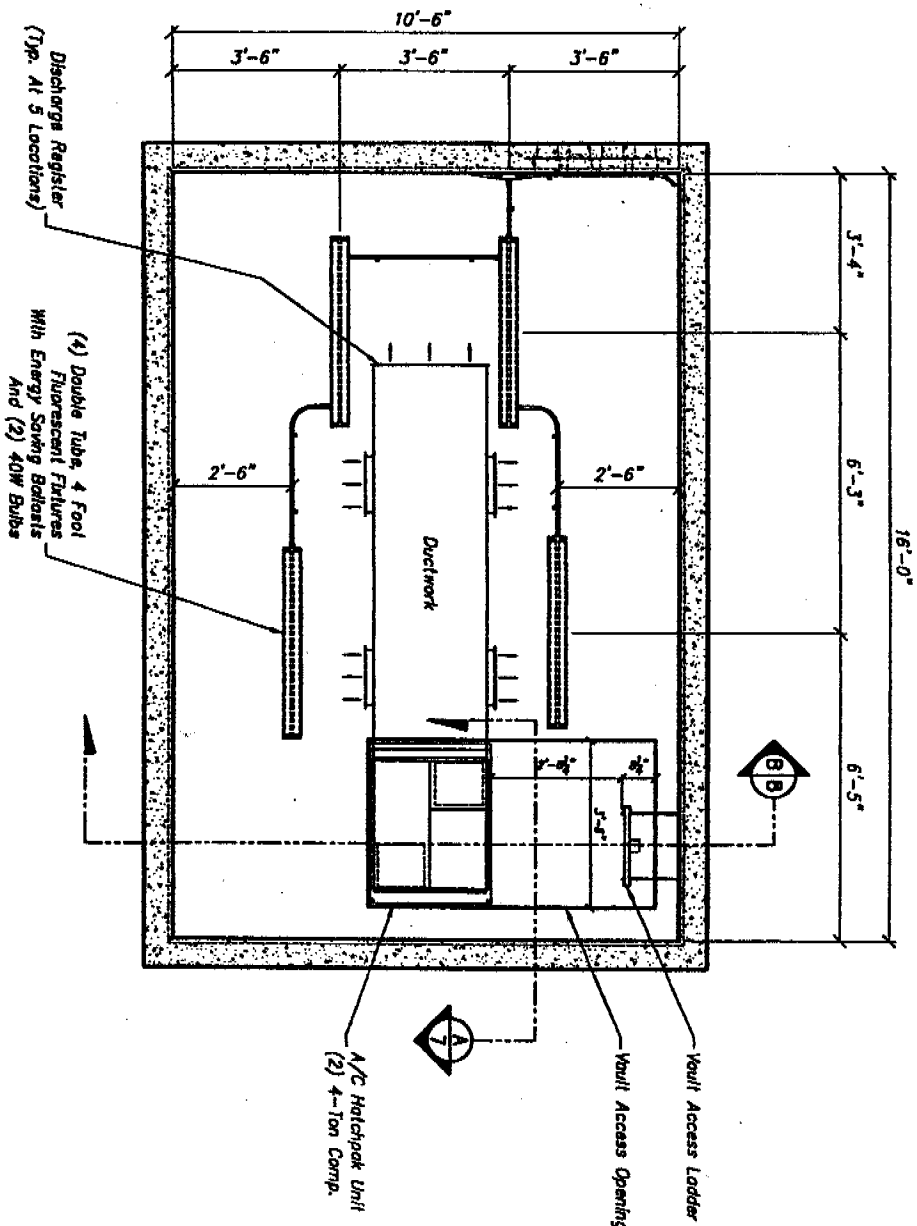


REFLECTED CEILING PLAN


REDUCED PRINT
1/2 Original Scale

DATE	SHEET	DATE	02/24/00
DESIGN		DATE	
APPROVED		DATE	
<p>THIS DRAWING IS THE PROPERTY OF THE UTILITY VAULT COMPANY. IT IS LOANED TO YOU FOR YOUR PROJECT ONLY. IT IS NOT TO BE REPRODUCED OR TRANSMITTED IN ANY FORM OR BY ANY MEANS, ELECTRONIC OR MECHANICAL, INCLUDING PHOTOCOPYING, RECORDING, OR BY ANY INFORMATION SYSTEMS. PERMISSION IS GRANTED TO REPRODUCE THIS DRAWING FOR THE PROJECT ONLY.</p>			
<p>UTILITY VAULT™ P.O. Box 610 Chandler, AZ 85244 (480) 963-2876 Fax: (480) 966-1037</p>		<p>Model 1016-106 Standard (Generation 2000) Pacific Bell</p>	<p>SCALE 1/2" = 1'-0" SHEET 3 OF 3</p>
<p>oldcastle Precast, Inc.</p>		<p>DELIVERY NO. J3000-3</p>	<p>REV.</p>


NO.	DATE	BY	CHKD.

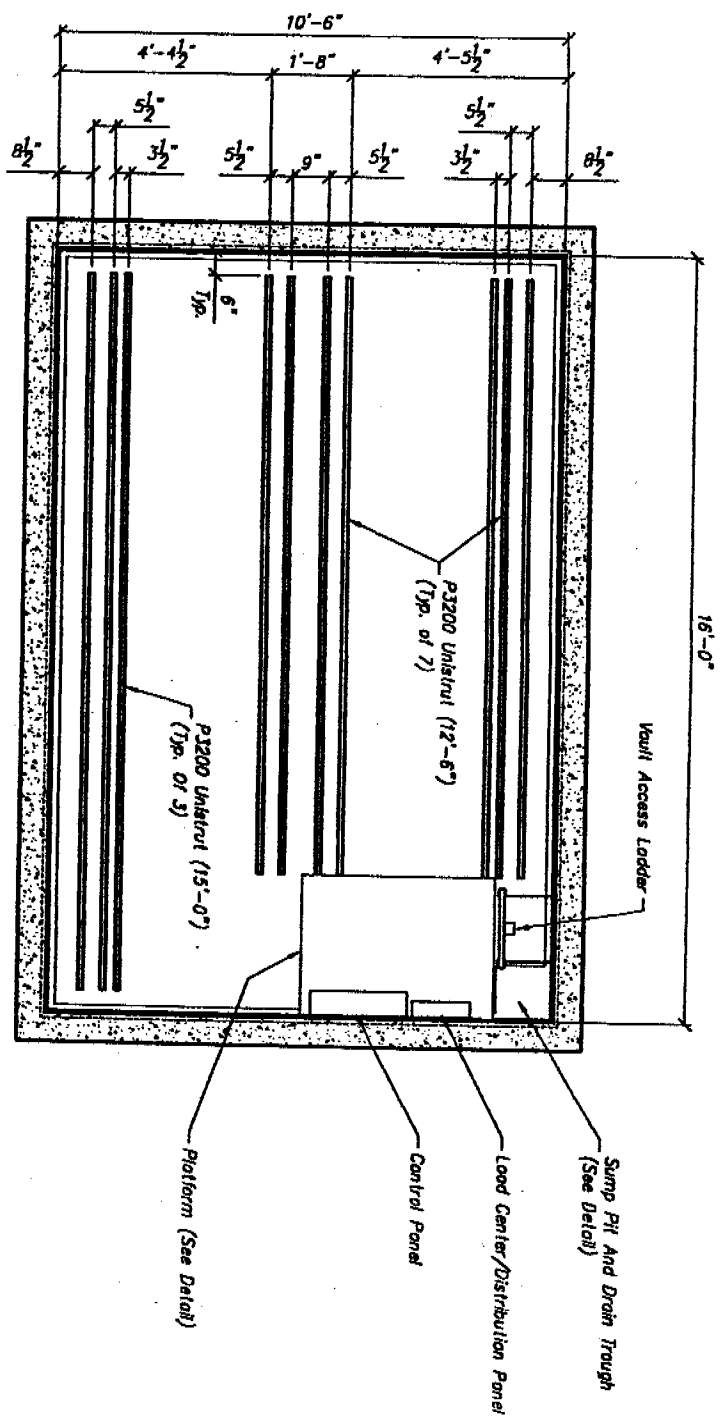

FLOOR LAYOUT

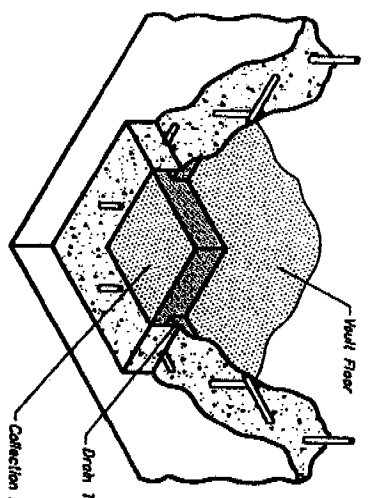

SUMP PIT DETAIL

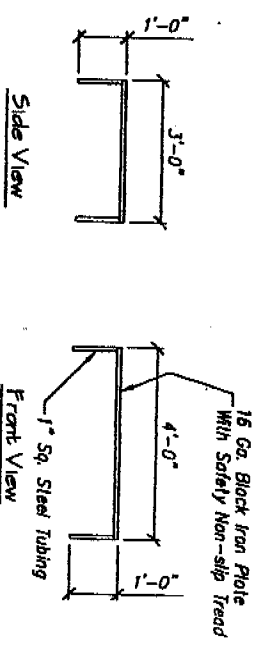

PLATFORM DETAIL

REVISION	DATE	BY	APP'D.	DESCRIPTION
	02/24/00			



ALL DRAWINGS IN THE PROPERTY OF THE
 PRECAST VAULT COMPANY. IT IS HEREBY
 AGREED THAT THE USER SHALL BE
 RESPONSIBLE FOR THE PROTECTION OF THIS DOCUMENT.
 SCALE: 1/2" = 1'-0"
 SHEET 4 OF 8
 DRAWING NO. 13000-4

Controlled Environment Vault
Model 1016-106 Standard (Generation2000)
Pacific Bell

UTILITY VAULT™
 P.O. Box 670, Chandler, AZ 85244
 (602) 952-8339 Fax: (602) 958-1187

Oldcastle Precast, Inc.

REDUCED PRINT
 1/2 Original Scale

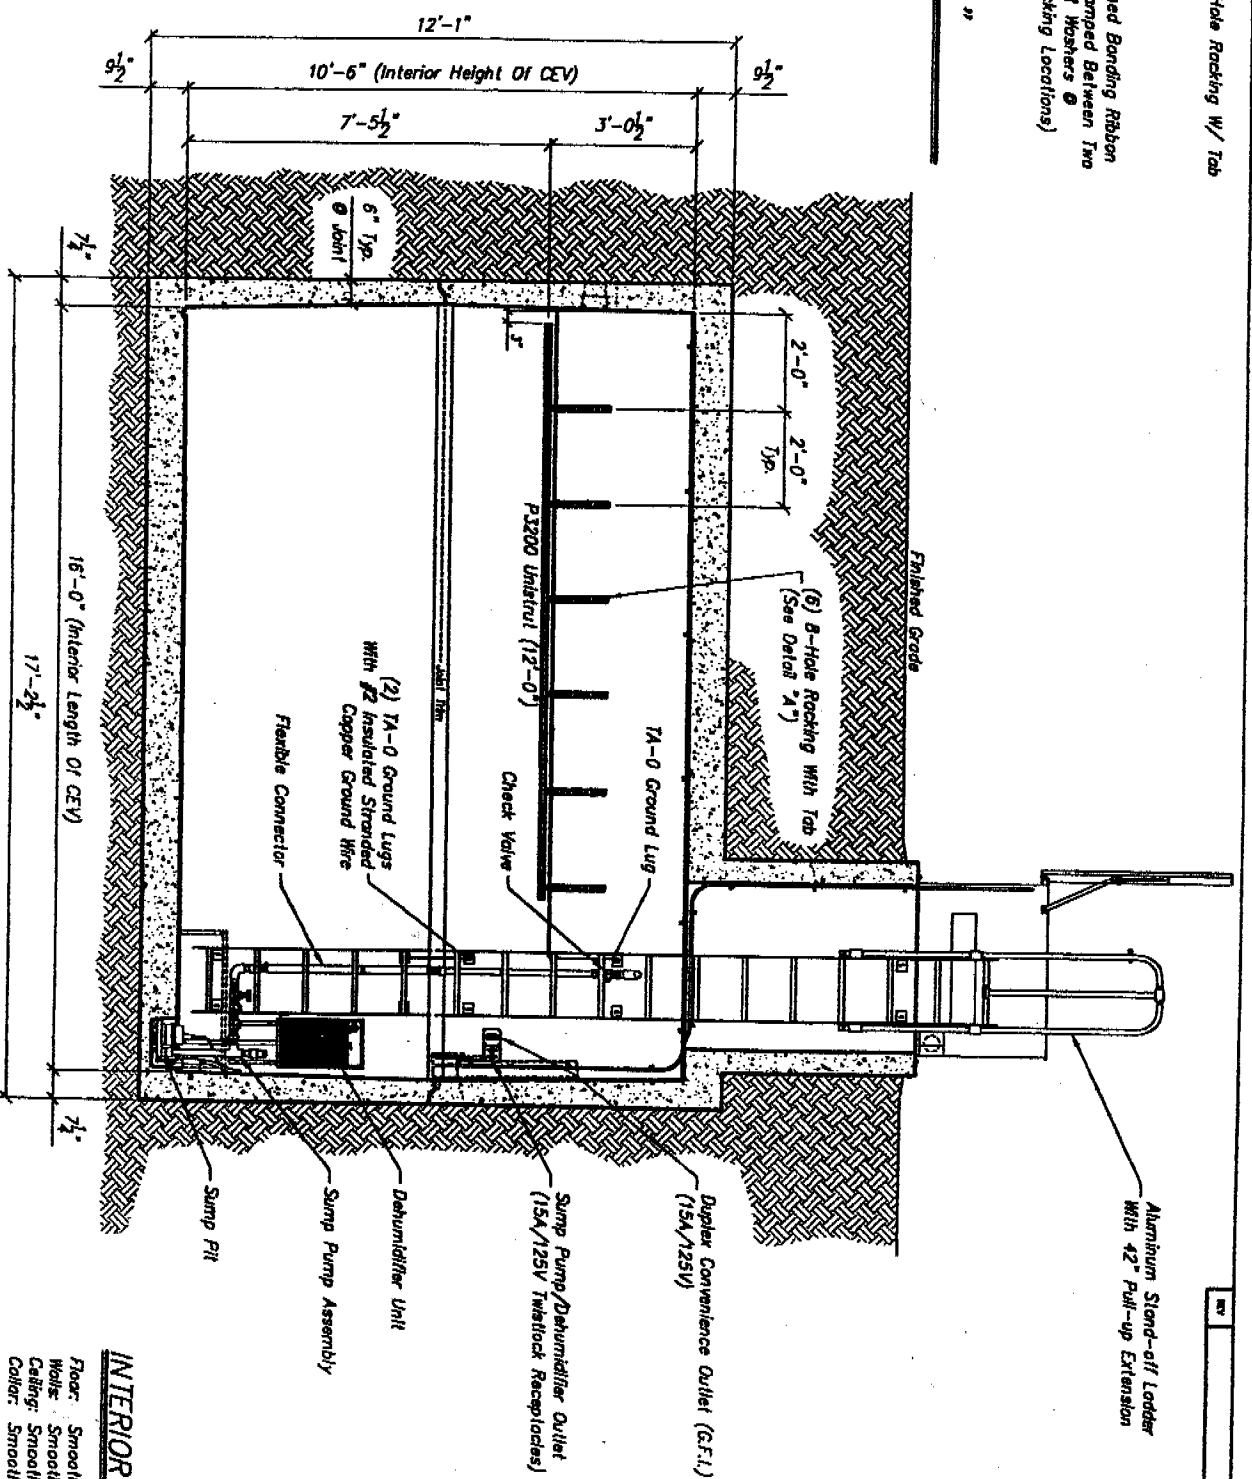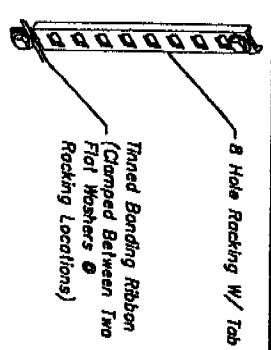

INTERIOR ELEVATION "A"

REDUCED PRINT
1/2 Original Scale

DATE	REV	DATE	BY
03/24/00			

Model 1016-106 Standard (Generation2000)
Pacific Bell

INTERIOR FINISH
Floor: Smooth Unfinished Concrete
Walls: Smooth White Paint
Ceiling: Smooth White Paint
Color: Smooth White Paint

UTILITY VAULT™
712, Box 810, Chandler, AZ 85244
(480) 966-8888 Fax: (480) 966-1187

SCALE: 1/2" = 1'-0" EA. HP
SHEET: 5 OF 8


DRAWING NO.: J3000-5

DATE: 03/24/00

BY: [Signature]

CONTROLLED ENVIRONMENT VAULT
Model 1016-106 Standard (Generation2000)
Pacific Bell


Oldcastle Precast, Inc.

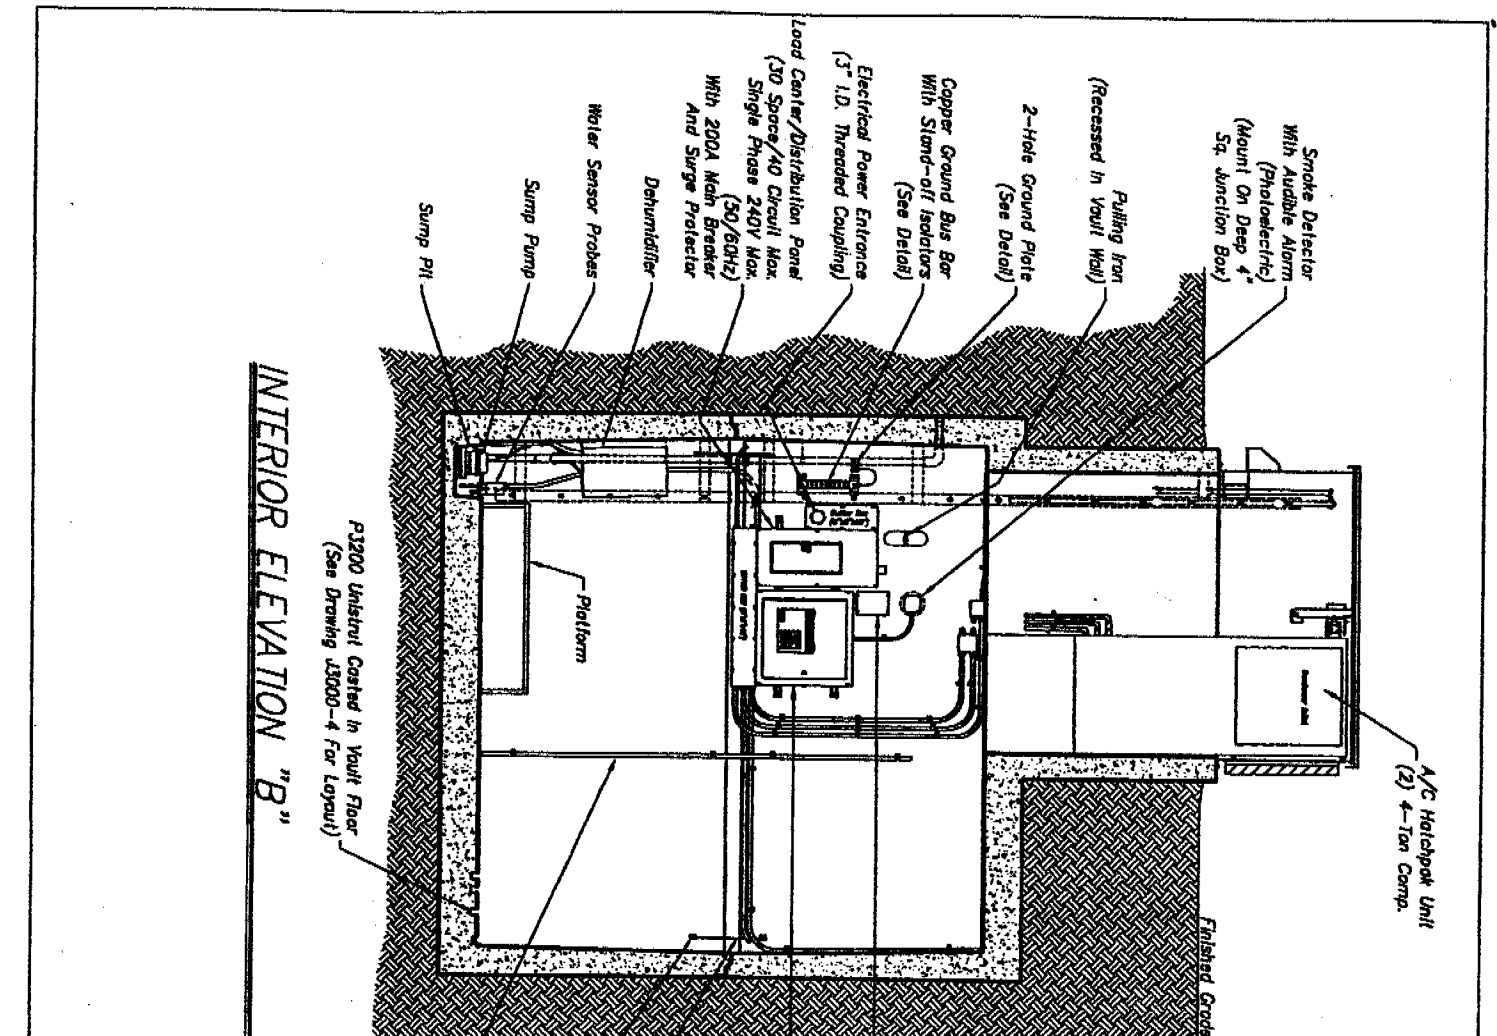

INTERIOR ELEVATION "B"

P1300 Unstrut Casted in Vault Floor
(See Drawing J3000-4 For Layout)


GROUND PLATE DETAIL

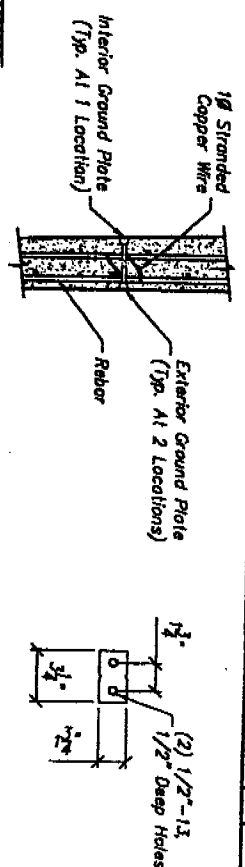

Scale: 2" = 1'-0"


Three 1-3/4" x 3-1/4" Trued Copper Plates Equal To Thermoweld #38-2999 Are Cast Into The Well, Mounted Flush With The Interior And Exterior Well Surfaces. The Interior And Exterior Ground Plate Assemblies Are Connected By Brazing A 1/8" Stranded Copper Wire From The Post Of The Interior Ground Plate To The Vault Rebar Cops. The Vault Rebar Cops Will Act As A User Grounding System. The Two Leads Coming From The Exterior Ground Loop Are Bolted To The Exterior Plate. Then Extending Them Onto The Master Ground Bar, Where They Are Terminated. This Method Eliminates The Need For A Penetration Of The Well, That Could Allow Water To Enter The Structure.

GROUND BAR DETAIL

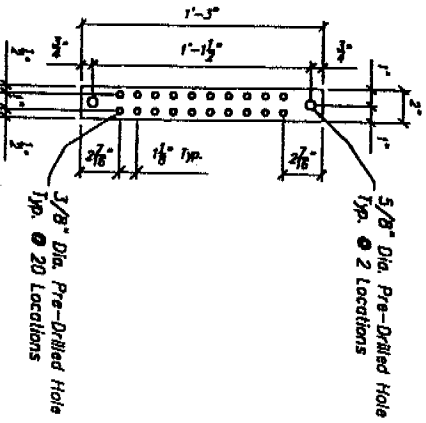


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DESIGNER	DATE	02/24/00
CHECKER	DATE	
APPROVED	DATE	
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SCALE	1/2" = 1'-0"	S&S No.
PROJECT	SR B	DRAWING NO.
		J3000-6
Controlled Environment Vault Model 1016-106 Standard (Generation2000) Pacific Bell		
UTILITY VAULT™ P.O. Box 810 Chandler, AZ 85224 (480) 948-8787 Fax (480) 948-1517		Oldcastle Precast, Inc.

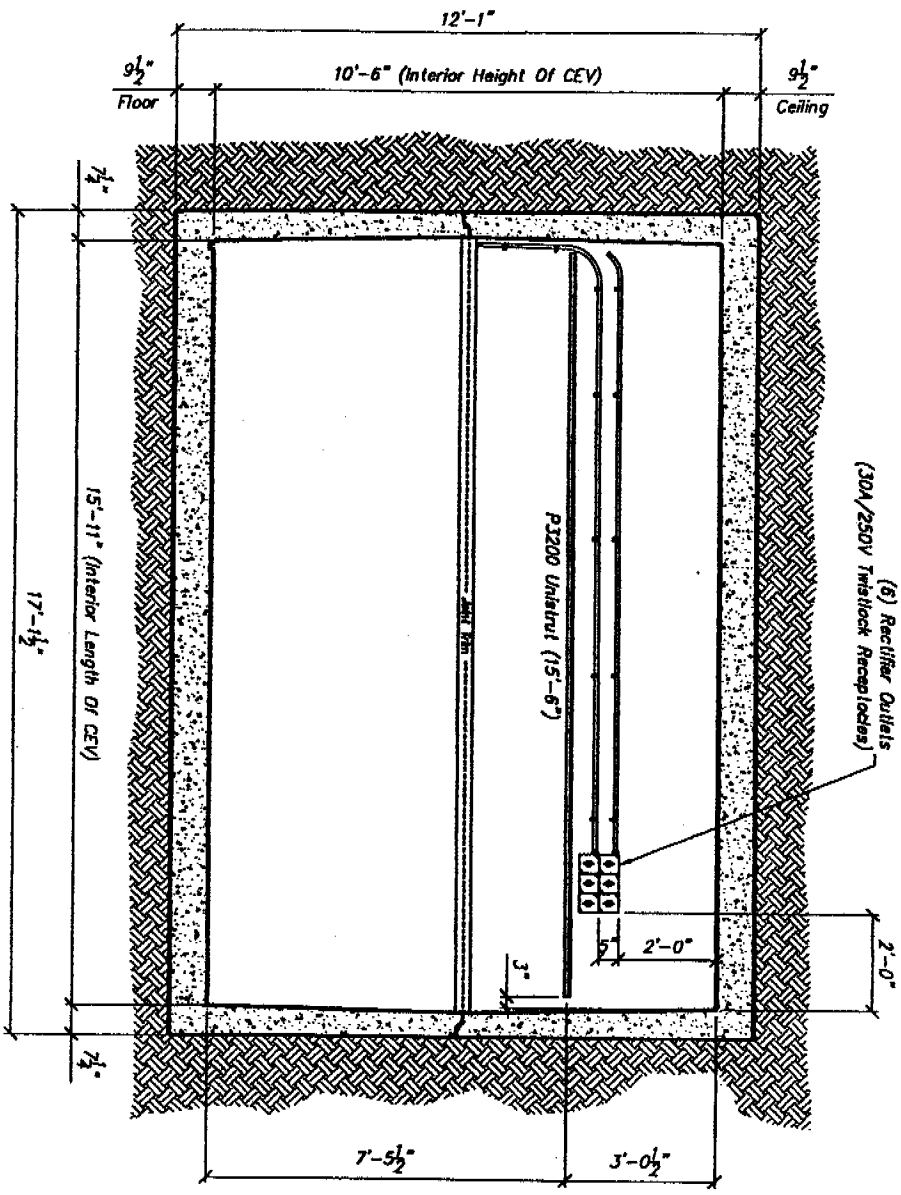

INTERIOR ELEVATION "C"

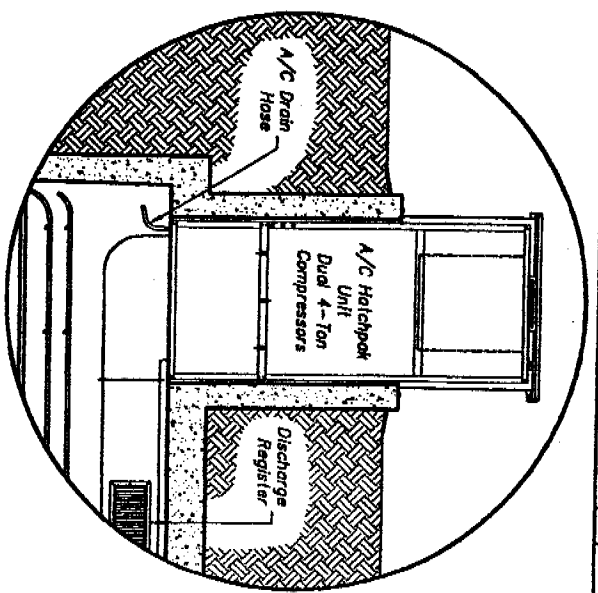



SECTION VIEW "A"

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1/2 Original Scale

DATE	NO.	REV.
03/24/00	1	
DESIGNED BY	CHECKED BY	DATE
THIS DRAWING IS THE PROPERTY OF THE COMPANY AND IS NOT TO BE REPRODUCED OR COPIED IN ANY MANNER WITHOUT THE WRITTEN PERMISSION OF THE COMPANY.		
SCALE	SHEET	TOTAL SHEETS
1/2" = 1'-0"	7 OF 8	
Model 1016-106 Standard (Generation2000) Pacific Bell		
DRAWING NO.		REV.
J3000-7		

UTILITY VAULT™
 P.O. Box 870, Channahon, IL 61018
 (815) 528-8878 Fax: (815) 528-1877



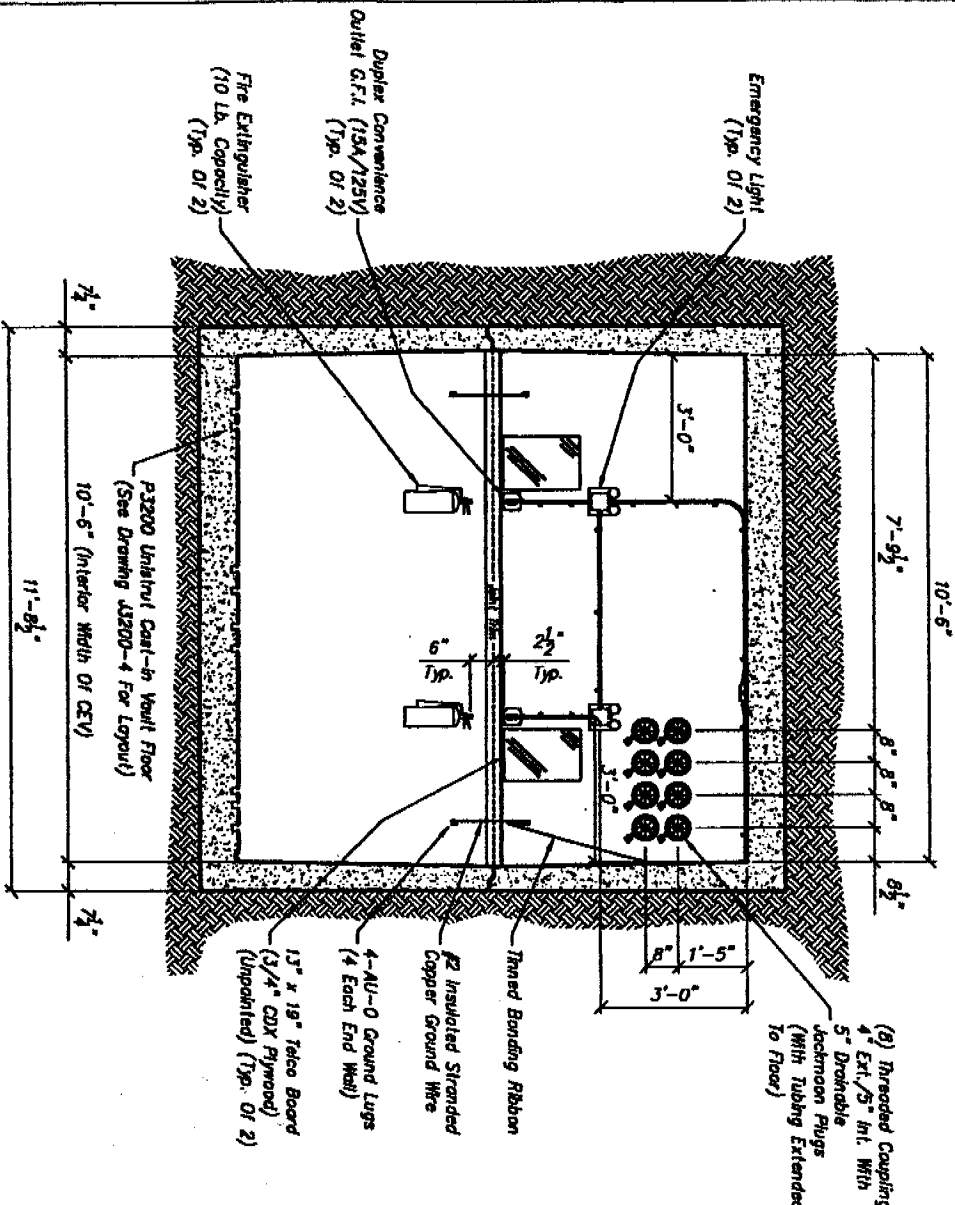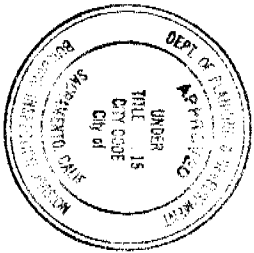


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ISSUED


SEP 0 5 2001

Sacramento Building Division

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SECTION VIEW "B"

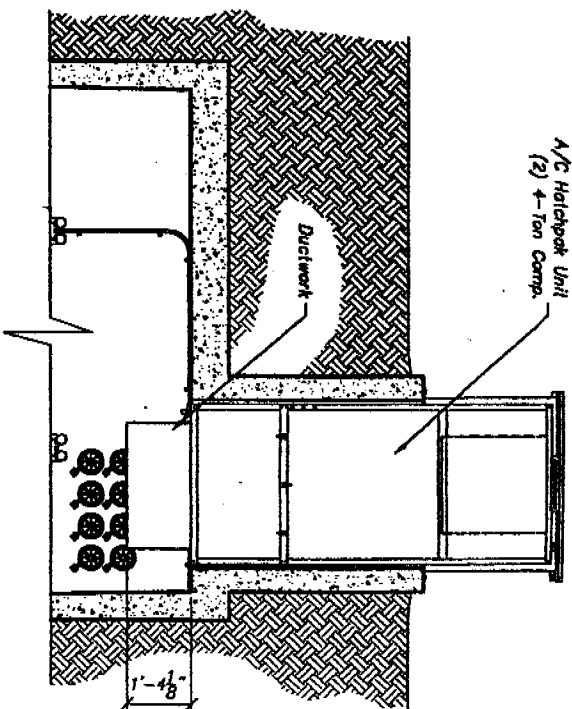

ENTRANCE WAY ASSEMBLY DETAIL

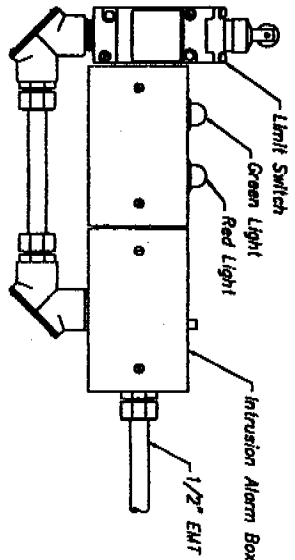REVISION	DATE	BY	DESCRIPTION
SR	01/10/00		
REVISED			
APPROVED			

Model 1016-106 Siderwalk (Generations2000)
Pacific Bell

DATE: 1/7/01
SCALE: 3/4" = 1'-0"
SHEET: 8 OF 8
JOB NO: J3200-8

UTILITY VAULT™
P.O. Box 510, Chandler, AZ 85224
(480) 966-5275 Fax: (480) 966-1257

okcaste Precast, Inc.

PERMIT SUMMARY DOCUMENT

Bldg Commercial
WAITING

Area: 4

Address: **3501 BROADGATE DR SAC** Date Issued:

Permit #: **0110390** Thomas Bros: 256 G7

Location: IN EXISTING VAULT

APN: 225-1480-042

Owner: PACIFIC BELL

Contractor: ROBERT F LEWIS
152 PHEASANT DR
GALT, CA
95632

Phone:

Phone: 209-744-1796

JOB DESCRIPTION: NEW PHONE SWITCHING VAULT, 200 AMP SERVICE PANEL

DBA:

PlanChecker's Update Screen:

General Info Screen:

Occupancy:

Change of Use: N

Zoning: ??

Const Type:

Sub-Type: NCOM

DR:

Fire Spk/1hr sub?: /

Activity Code: N1

Fed Code: 16

Flood Zone: A99

Cert Req'd: N

Balance: \$213.82

Square Footage: 0

VALUATION: \$1,500.00 Reg San: \$0.00 School Fees Req'd: Y or N

BLDG N MECH Y PLBG Y ELEC Y SITE ~~N~~ FIRE N

BLDG L/S MECH PLBG ELEC SITE FIRE UTIL PW

Cycle 1

Cycle 2

Cycle 3

Cycle 4

CONDITIONS:

APPLICATION FOR COMMERCIAL BUILDING PERMIT

256-67

CITY OF SACRAMENTO
 DEVELOPMENT SERVICES DIVISION
 PERMIT SERVICES SECTION
 1231 I Street, Rm. 200
 Sacramento, CA 95814 (916) 264-7619 FAX 264-7046

ACTIVITY #	Insp. Area
0110390	4C

Applicant MUST complete ALL Unshaded areas

ADDRESS 3501 BROADGATE DR Suite _____
 PARCEL # 225-1480-042

CONTACT		LICENSED CONTRACTOR Lic No. # <u>607692</u>	
Name _____	Street Address _____	Name <u>ROBERT F LEWIS</u>	Address <u>152 PLEASANT DR</u>
City/State/Zip _____	Phone _____ FAX _____	City/State/Zip <u>GALT, CA 95632</u>	Phone <u>(209) 744-1796</u> FAX <u>(209) 744-1797</u>
E-mail: _____		E-mail: _____	
ARCHITECT/ENGINEER		OWNER	
Name _____	Address _____	Name <u>JAC</u>	Address _____
City/State/Zip _____	Phone _____ FAX _____	City/State/Zip _____	Phone _____ FAX _____
E-mail: _____		E-mail: _____	

→ Will permittee have any employees on the jobsite? No Yes → INSURANCE CO: _____
 → WORKER'S COMPENSATION POLICY # _____ EXPIRATION DATE: _____

NATURE OF WORK IN DETAIL:
NEW PHONE SWITCHING VAULT

OCCUPANT/TENANT: _____ VALUATION: \$ 1500

FLOOD STATUS:		S.C.A.T.								
JOB DESCRIPTION		BLDG	SHELL	APT	TI()	REM()	SW	FIRE	ADD	<u>OTH</u>
INSPECTION DISCIPLINES		BLDG	<u>MECH</u>	<u>PLUMB</u>	<u>ELEC</u>	SITE		FIRE		
# Stories	1st firArea	Total Area	Use Zone	Occp Group	Const type	Fire Req. Y / N		Fed Code	Vio. File	
						SPR	ALARM	<u>16</u>	[H]	[Quad]
<u>B</u>	<u>L</u>	<u>P</u>	<u>M</u>	<u>E</u>	<u>F</u>	<u>S</u>	<u>D</u>	<u>SANS</u>	PW	UTIL
				<u>N/A LAB</u>						

COMMENTS: ENCROACHMENT PERMIT # 2001-353

REGIONAL SANITATION FEES? Yes No HEALTH DEPARTMENT? Yes No
 WATER FLOW TEST FOR NEW BUILDINGS OR ADDITIONS? Provided Faxed